
	PLANS	BY	DAT
	DESIGNED		
	CHECKED		
	DELINEATED		
MEER *	5930 Cor San Diego Tel 858.4	- Serving Public Agence merstone Ct. West, Ste o, California 92121 67.6950, Fax 858.467.	300

Basis of Bearings
Zone 6

California Coordinate 83

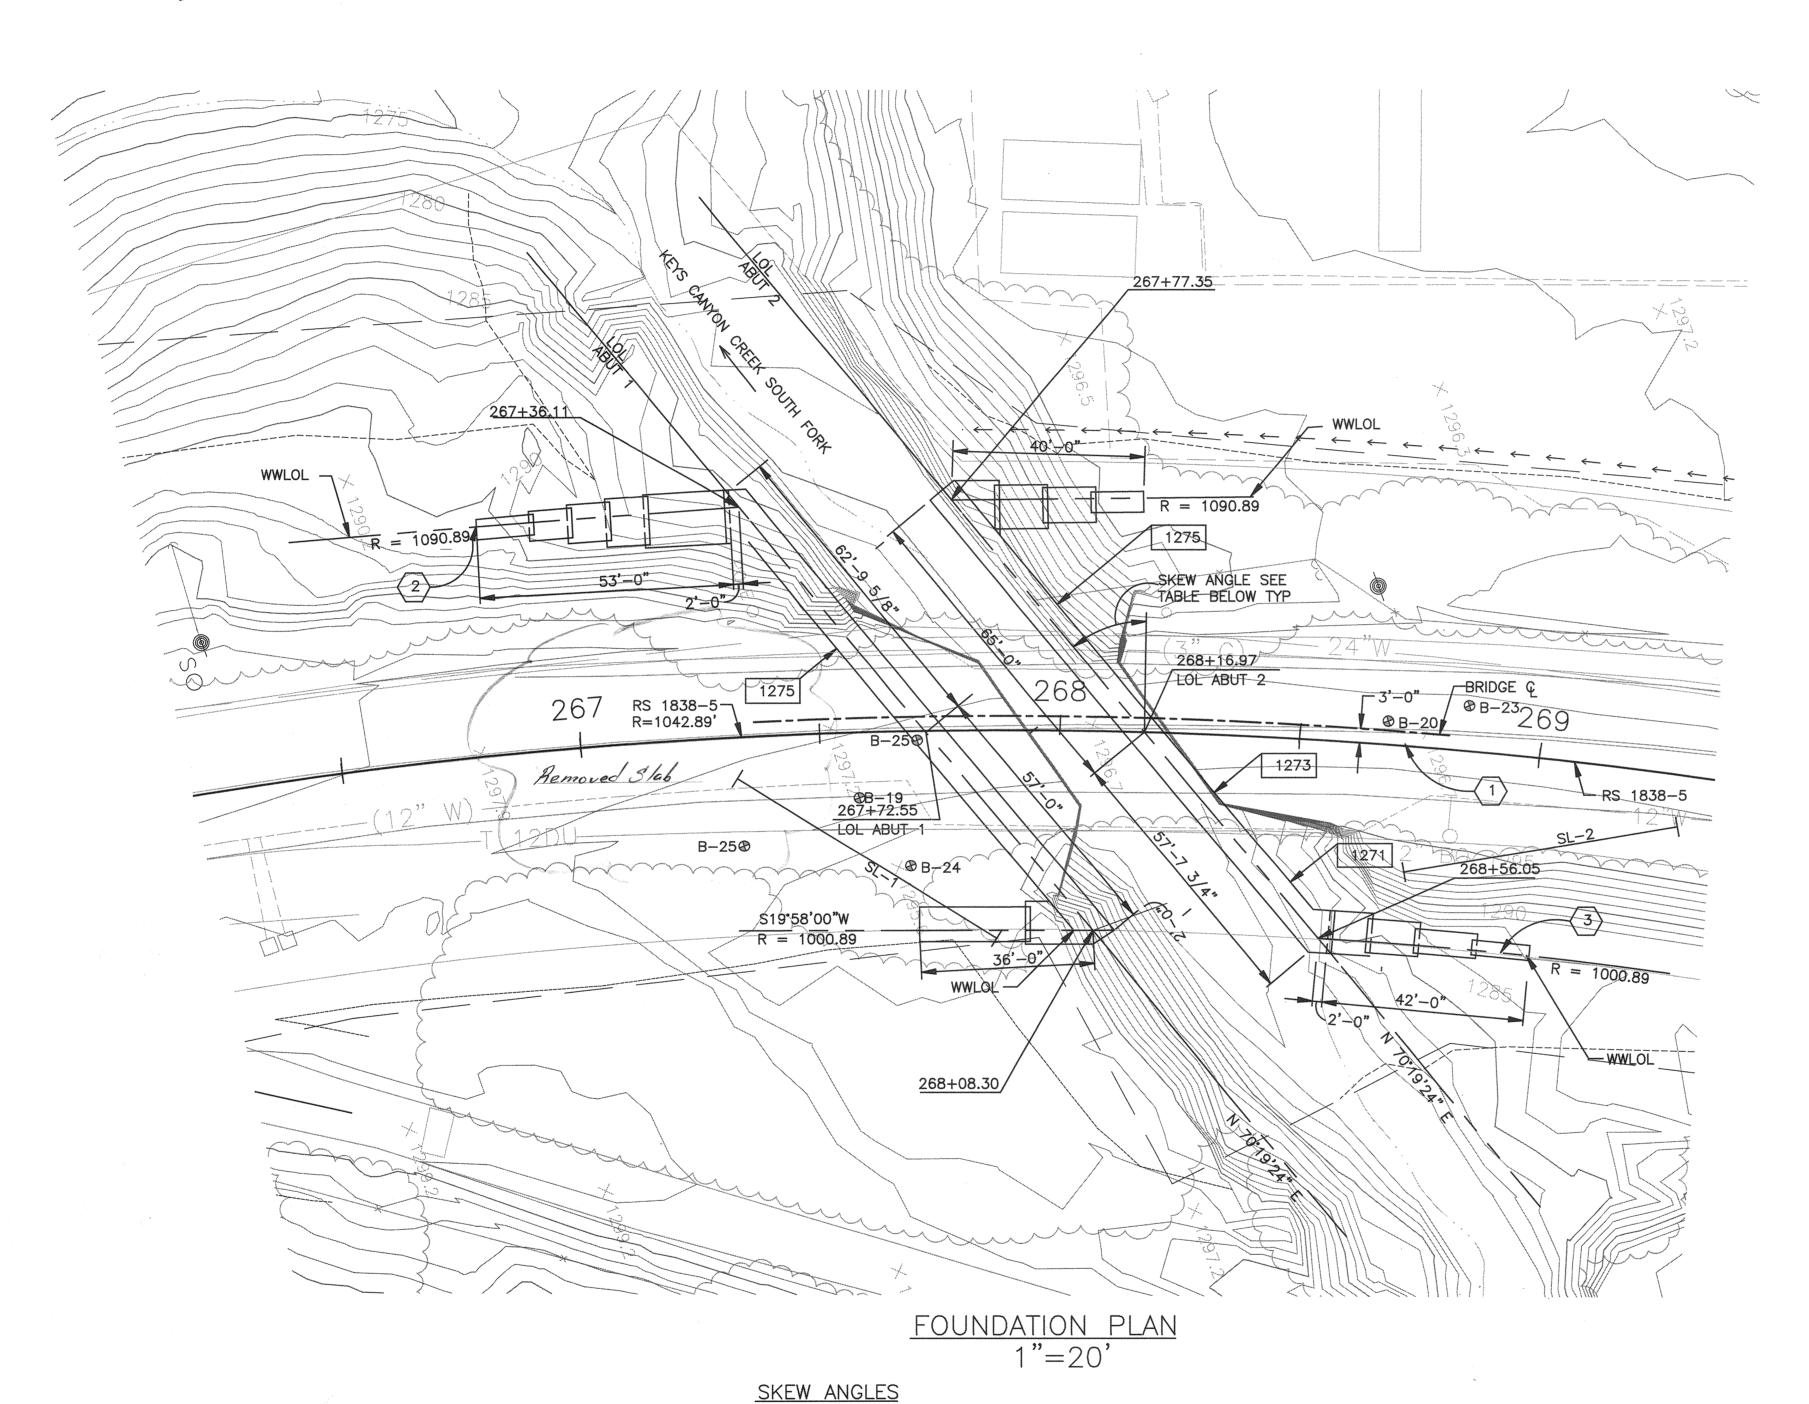

STATE OF CALIFORNIA

DEPARTMENT OF TRANSPORTATION

STANDARD PLANS DATED JULY 1992

A10A ABBREVIATIONS

A10B SYMBOLS

A62C LIMITS OF PAYMENT FOR EXCAVATION AND BACKFILL BRIDGE

T3 TEMPORARY RAILING (TYPE K)

80-1 BRIDGE DETAILS

B0-3 BRIDGE DETAILS
B0-5 BRIDGE DETAILS

3-1 RETAINING WALL TYPE 1 H=4'-30'

B3-8 RETAINING WALL DETAILS NO.1

B3-9 RETAINING WALL DETAILS NO.2

36-1 T-BEAM DETAILS 36-10 UTILITY OPENINGS T-BEAM

B6-21 JOINT SEALS (MAXIMUM MOVEMENT RATING = 2")

B7-5 DECK DRAINS

B7-6 DECK DRAINS TYPES D-1 AND D-2

B11-7 CHAIN LINK RAILING

B11-51 TUBULAR HAND RAILING

B11-53 CONCRETE BARRIER (TYPE 732)

B11-54 CONCRETE BARRIER (TYPE 26)

STANDARD PLAN SHEET NO.

DETAIL NO.

NOTE:

PRIOR TO PLACEMENT OF BAR REINFORCING STEEL, THE EXCAVATED FOOTINGS SHALL BE INSPECTED AND APPROVED BY THE ENGINEER.

LOCATION OF TEST BORING

DENOTES BOTTOM OF FOOTING ELEVATION

HYDROLOGIC DATA SUMMARY

HYDROLOGIC SUMMARY	STANDARD FLOOD	DESIGN FLOOD
FREQUENCY (YRS)	100	100
DISCHARGE (CFS)	6000	6000
WATER SUFACE ELEV. (FT)	1288.22	1288.22
VELOCITY (FPS)	14.9	14.9

COUNTY OF SAN DIEGO
DEPARTMENT OF PUBLIC WORKS
5555 OVERLAND AVENUE, SAN DIEGO, CA 92123-1295



ABUTMENT 1

ABUTMENT 2

41°16'52"

FIELD REVISIONS

VALLEY CENTER ROAD BRIDGE OVER
KEYS CYN CREEK S FORK 57C-0185
FOUNDATION PLAN

SCALE: HOR. 1"=20' VERT. N/A

W.A. UJ1101 R.S. 1838—3 TO —6

SP 345 4 OF 14

SHEET 225R OF 256 SHEETS

SP 345